

PARTIAL NORTH ELEVATION A3.3/1/4" = 1'-0"

EXTERIOR MATERIALS SCHEDULE

- ROOFING-COMPOSITION SHINGLES: . ROOFING TO BE COMPOSITION ROOF SHINGLES AS SUPPLIED BY OWENS CORNING OR APPROVED ALTERNATIVE OVER 15# MIN. ASPHALT IMPREGNATED BUILDING FELT PER MANUFACTURER'S RECOMMENDATIONS.
- 2. PROVIDE AN ICE AND WATER SHIELD MEMBRANE AS SUPPLIED BY W.R. GRACE, OR APPROVED ALTERNATIVE, AT ALL EAVES NO LESS THAN 3'-0" OF ROOF SLOPE FROM WALL LINE AND DOWN TO EDGE OF EAVES. ALSO PROVIDE SAME MEMBRANE AT ALL VALLEYS, ROOF VENTS, ROOF PENETRATIONS, AND AS INDICATED ON THE ROOF PLAN. APPLY MEMBRANE DIRECTLY OVER SHEATHING, AND ENSURE ALL LAPS AND COVERAGE IS IN CONFORMANCE WITH THE MANUFACTURER'S RECOMMENDATIONS.
- 3. NAILS TO BE PROPER GAUGE RUST-RESISTANT OR ZINC-COATED SHINGLE NAILS SUITABLE FOR COMPOSITION SHINGLE INSTALLATION.
- 4. ALL MATERIALS AND WORKMANSHIP SHALL MEET OR EXCEED ALL PUBLISHED ROOFING INDUSTRY STANDARDS.
- 5. PROVIDE STANDARD WARRANTY AGAINST LEAKAGE AND DEFECTS IN MATERIALS AND WORKMANSHIP.

METAL ROOFING

- 1. ALL METAL ROOFING TO BE 22 GAUGE COLOR COATED CORRUGATED METAL. INSTALLATION TO BE AS RECOMMENDED BY MANUFACTURER.
- 2. PROVIDE AN ICE AND WATER SHIELD MEMBRANE SUITABLE FOR METAL ROOFING APPLICATIONS AS SUPPLIED BY W.R. GRACE, OR APPROVED ALTERNATIVE, AT ALL EAVES NO LESS THAN 3'-0" OF ROOF SLOPE FROM WALL LINE AND DOWN TO EDGE OF EAVES. ALSO PROVIDE SAME MEMBRANE AT ALL VALLEYS, ROOF VENTS, ROOF PENETRATIONS, AND AS INDICATED ON THE ROOF PLAN. APPLY MEMBRANE DIRECTLY OVER SHEATHING, AND ENSURE ALL LAPS AND COVERAGE IS IN CONFORMANCE WITH THE MANUFACTURER'S RECOMMENDATIONS.
- 3. CONTRACTOR TO ENSURE THAT ALL SEAMS ARE ADEQUATELY SEALED AGAINST
- METAL FLASHÌNG: I. ALL FLASHING AT FASCIA EDGES, WINDOW AND DOOR CAPS, SIDING TRANSITIONS, ROOF TO WALL INTERSECTIONS, AND ALL OTHER EXPOSED METAL FLASHING TO BE PAINT-LOCKED, COLOR TO BE DETERMINED BY OWNER. GAUGE THICKNESS TO MEET OR EXCEED STANDARDS PUBLISHED BY THAT TRADE. ALL NON-EXPOSED FLASHING MAY BE GALVANIZED OR APPROVED ALTERNATIVE.
- 2. FLASHING TOLERANCES SHALL NOT BE LESS THAN THAT PUBLISHED BY THAT TRADE.
- 3. STEP FLASHING SHALL BE USED WHERE VERTICAL SURFACES OCCUR IN CONNECTION WITH WOOD SOFFIT: RAKE ENDS OF ROOF SLOPES.
- 4. VALLEY FLASHING TO HAVE RAISED RIDGE PROFILE TO PREVENT ROOF SHEET DRAINAGE FROM BACK WASHING UP UNDER ROOF MATERIAL AT OPPOSITE SIDE OF
- SYNTHETIC STUCCO (EXTERIOR INSULATION FINISH SYSTEM, EIFS): 1. ALL SYNTHETIC STUCCO SYSTEMS TO BE INSTALLED IN ACCORDANCE WITH THE MANUFACTURER'S INSTALLATION INSTRUCTIONS AND THE REQUIREMENTS OF THIS SECTION. THE SYNTHETIC STUCCO SYSTEM TO TERMINATE NO LESS THAN 6 INCHES ABOVE THE FINISHED GROUND LEVEL.
- 2. ALL SYNTHETIC STUCCO SYSTEMS TO HAVE A WEATHER-RESISTANT BARRIER APPLIED BETWEEN THE UNDERLYING WATER-SENSITIVE BUILDING COMPONENTS AND THE EXTERIOR WOOD RAILINGS; INSULATION, AND A MEANS OF DRAINING WATER TO THE EXTERIOR OF THE VENEER. A WEATHER-RESISTANT BARRIER SHALL BE COMPLIANT WITH ASTM D 226 TYPE I ASPHALT SATURATED FELT OR EQUIVALENT, TO BE APPLIED HORIZONTALLY WITH THE UPPER LAYER LAPPED OVER THE LOWER LAYER NOT LESS THAN 2 INCHES, AND HAVE ALL VERTICAL JOINTS LAPPED NOT LESS THAN 6 INCHES.
- 3. FLASHING OF THE SYNTHETIC STUCCO SYSTEM TO BE PROVIDED IN ACCORDANCE WITH THE REQUIREMENTS OF SECTION RT03.8 OF THE INTERNATIONAL RESIDENTIAL CODE.
- 4. PROVIDE CONTROL JOINTS, PER MANUFACTURER'S RECOMMENDATION. LOCATIONS OF ALL CONTROL JOINTS: TO BE APPROVED BY ARCHITECT.

HORIZONTAL WOOD SIDING:

- . HORIZONTAL WOOD SIDING TO BE I imes 6 CLAPBOARD WITH 5" EXPOSURE, GRADE "C" OR BETTER, WESTERN RED CEDAR WITH RESAWN FACE. 2. NAILS TO BE PROPER GAUGE RUST-RESISTANT OR ZINC COATED NAILS FOR SIDING
 - VERTICAL WOOD SIDING TO BE 1 x 6, GRADE 'C' OR BETTER, WESTERN RED CEDAR WITH RESAWN FACE, PROVIDE SHIP-LAPPED PROFILE WITH SQUARE BUTT JOINTS.
 - 2. PROVIDE PROPER BACKING FOR NAILING.
 - 3. NAILS TO BE PROPER GAUGE RUST RESISTANT OR ZINC COATED SHINGLE NAILS FOR SIDING APPLICATIONS.
 - VERTICAL WOOD BOARD & BATTEN SIDING: . 1×10 vertical board with 1×3 vertical batten, grade "C" or better, western RED CEDAR WITH RESAWN FACE. PROVIDE SPACING TO ALLOW 9" EXPOSURE.
 - 2. PROVIDE PROPER BACKING FOR NAILING. 3. NAILS TO BE PROPER GAUGE RUST RESISTANT OR ZINC COATED SHINGLE NAILS FOR

SIDING APPLICATIONS. EXPOSED RAFTERS AND RAFTER TAILS:

- 1. No. 1 DOUG FIR, 645, RE: STRUCTURAL DRAWINGS AND SPECIFICATIONS
- WOOD BEAMS, POSTS, AND KNEE BRACES: 1. No. 1 DOUG FIR, \$45, RE: STRUCTURAL DRAWINGS AND SPECIFICATIONS
- 2. ALL JOINTS TO BE TIGHT AND FREE OF GAPS.
- 3. ALL CONNECTIONS TO BE EXPOSED USING EXPOSED BOLTS, RE: STRUCTURAL DRAWINGS
- WOOD TRIM, WINDOW AND DOOR TRIM, FASCIA TRIM: . GRADE 'B' OR BETTER, WESTERN RED CEDAR WITH RESAWN FACE. PROVIDE RESAWN
- NAILS TO BE PROPER GAUGE RUST RESISTANT OR ZINC COATED SHINGLE NAILS FOR SIDING APPLICATIONS.

SIDING APPLICATIONS.

OR BETTER.

TEXTURE ON ALL EXPOSED SURFACES.

- 3. ALL TRIM SIZES AS PER DETAILS.
- I. WOOD SOFFIT TO BE I \times 6, GRADE 'C' OR BETTER, WESTERN RED CEDAR WITH SMOOTH FACE. PROVIDE TONGUE AND GROOVE PROFILE WITH SQUARE BUTT JOINTS. 2. NAILS TO BE PROPER GAUGE RUST RESISTANT OR ZINC COATED SHINGLE NAILS FOR
- WOOD DECKING: 1. WOOD DECK BOARDS TO BE 2 \times 6, DECK HEART GRADE REDWOOD WITH SMOOTH FACE. 2. SCREW DECKING TO STRUCTURAL FRAMING WITH PROPER GAUGE AND DIMENSION RUST

RESISTANT OR ZINC COATED SCREWS. USE SQUARE DRIVE SCREW HEADS. PRE-DRILL

AND COUNTERSINK.

- 1. ALL RAILS TO BE 2x WESTERN RED CEDAR, GRADE "B" OR BETTER, SMOOTH SAWN. 2. ALL VERTICAL BALUSTERS TO BE 2 x 2, SMOOTH SAWN, WESTERN RED CEDAR, GRADE "B"
- CONCRETE SLABS AT COVERED PORCHES: 1. CONCRETE SLABS TO BE STAMPED AND STAINED, COLOR TO BE DETERMINED.

EXTERIOR ELEVATION LEGEND

в Др.	DETAIL NUMBER SHEET NUMBER
X A**	WALL SECTION LETTER SHEET NUMBER
888	DOOR NUMBER
888	WINDOW NUMBER
\diamondsuit	TEMPERED GLASS
	CENTER LINE
\triangle	REVISION NUMBER
\$ SD [#]	REVISION NUMBER SUPPLEMENTAL DWG. NO.
•	REFERENCE ELEVATION

STAR VALLEY RANCH **ASSOCIATION**

TOWN OF STAR VALLEY RANCH LINCOLN COUNTY, WYOMING



1160 Alpine Lane, STE 2A 37 North First East ро вох 9227 Jackson, wy 83002 ро вох 169 Driggs, 1D 83422


PHONE: (208) 354-0151


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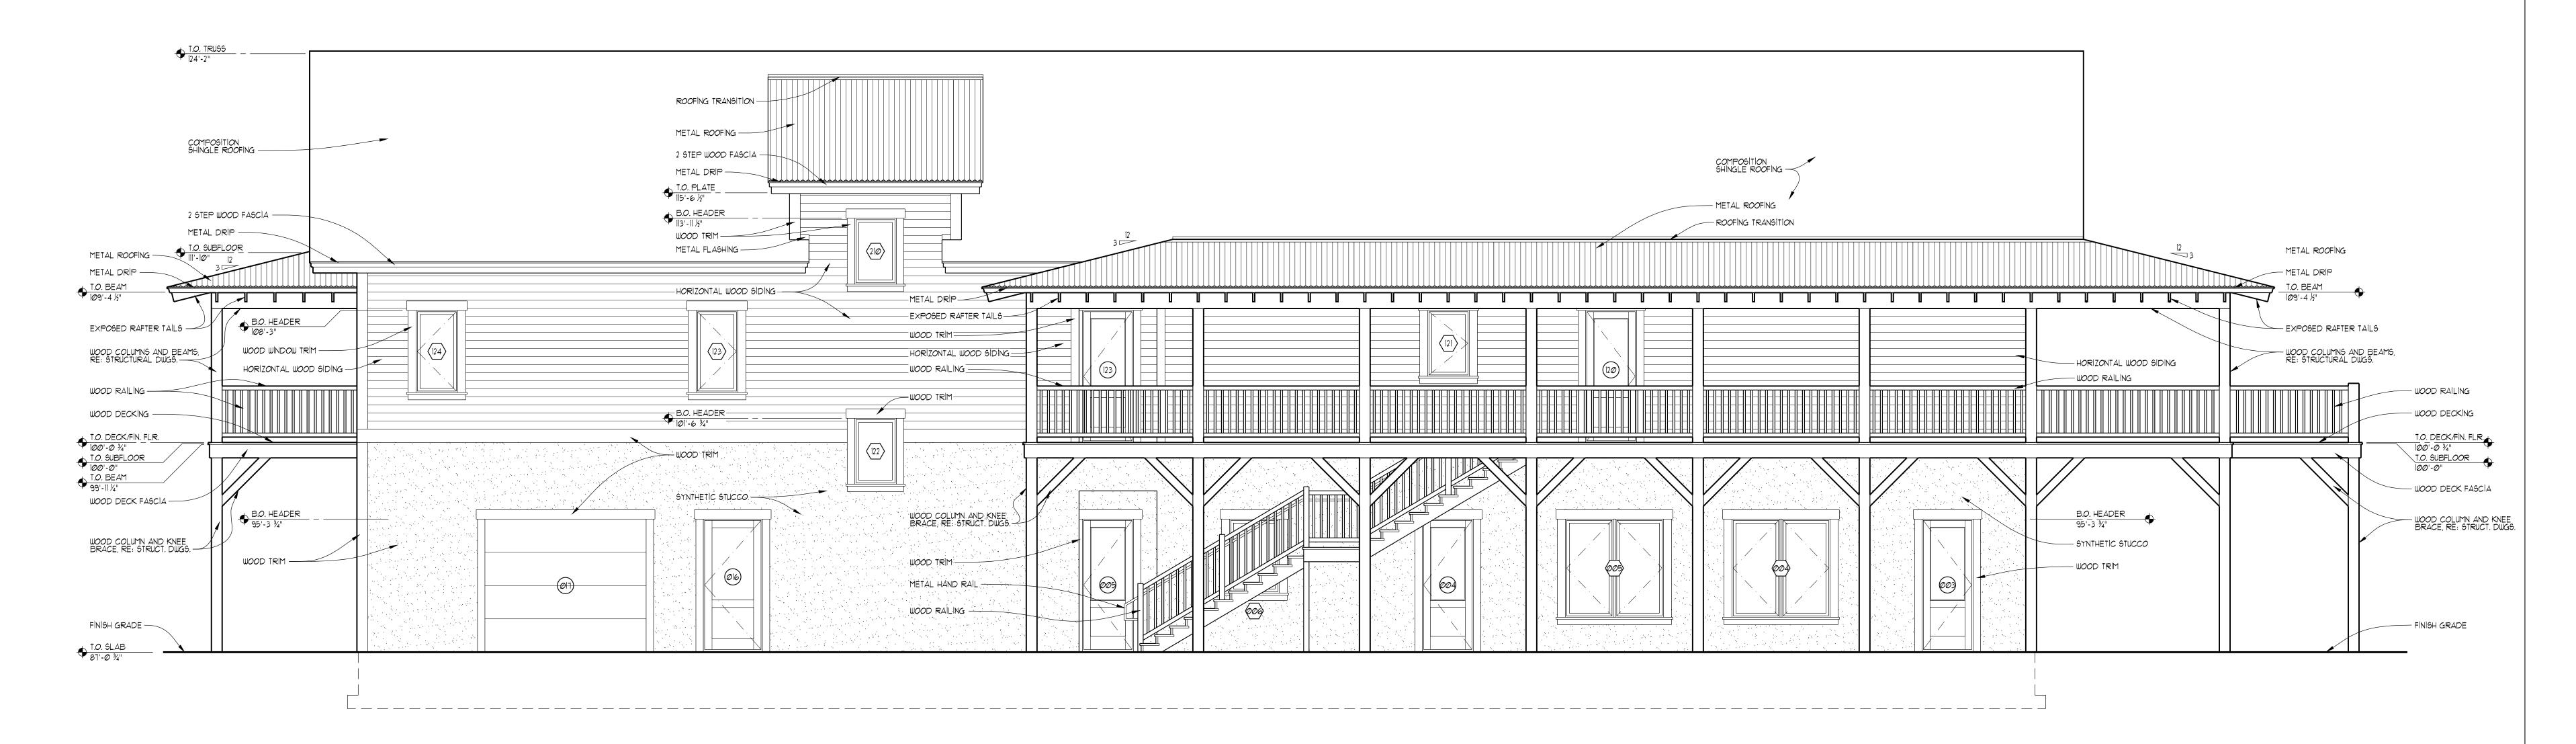
PHONE: (307) 733-9551

EXTERIOR ELEVATIONS


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	BID SET	NOVEMBER 15, 2013	
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	Plot Date: NOVEMBER 15, 2013	Sheet Number:	
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NORTH ELEVATION A3.2 1/4" = 1'-0"

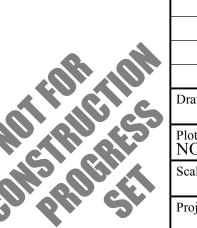

2 WEST ELEVATION
A3.2 1/4" = 1'-0"

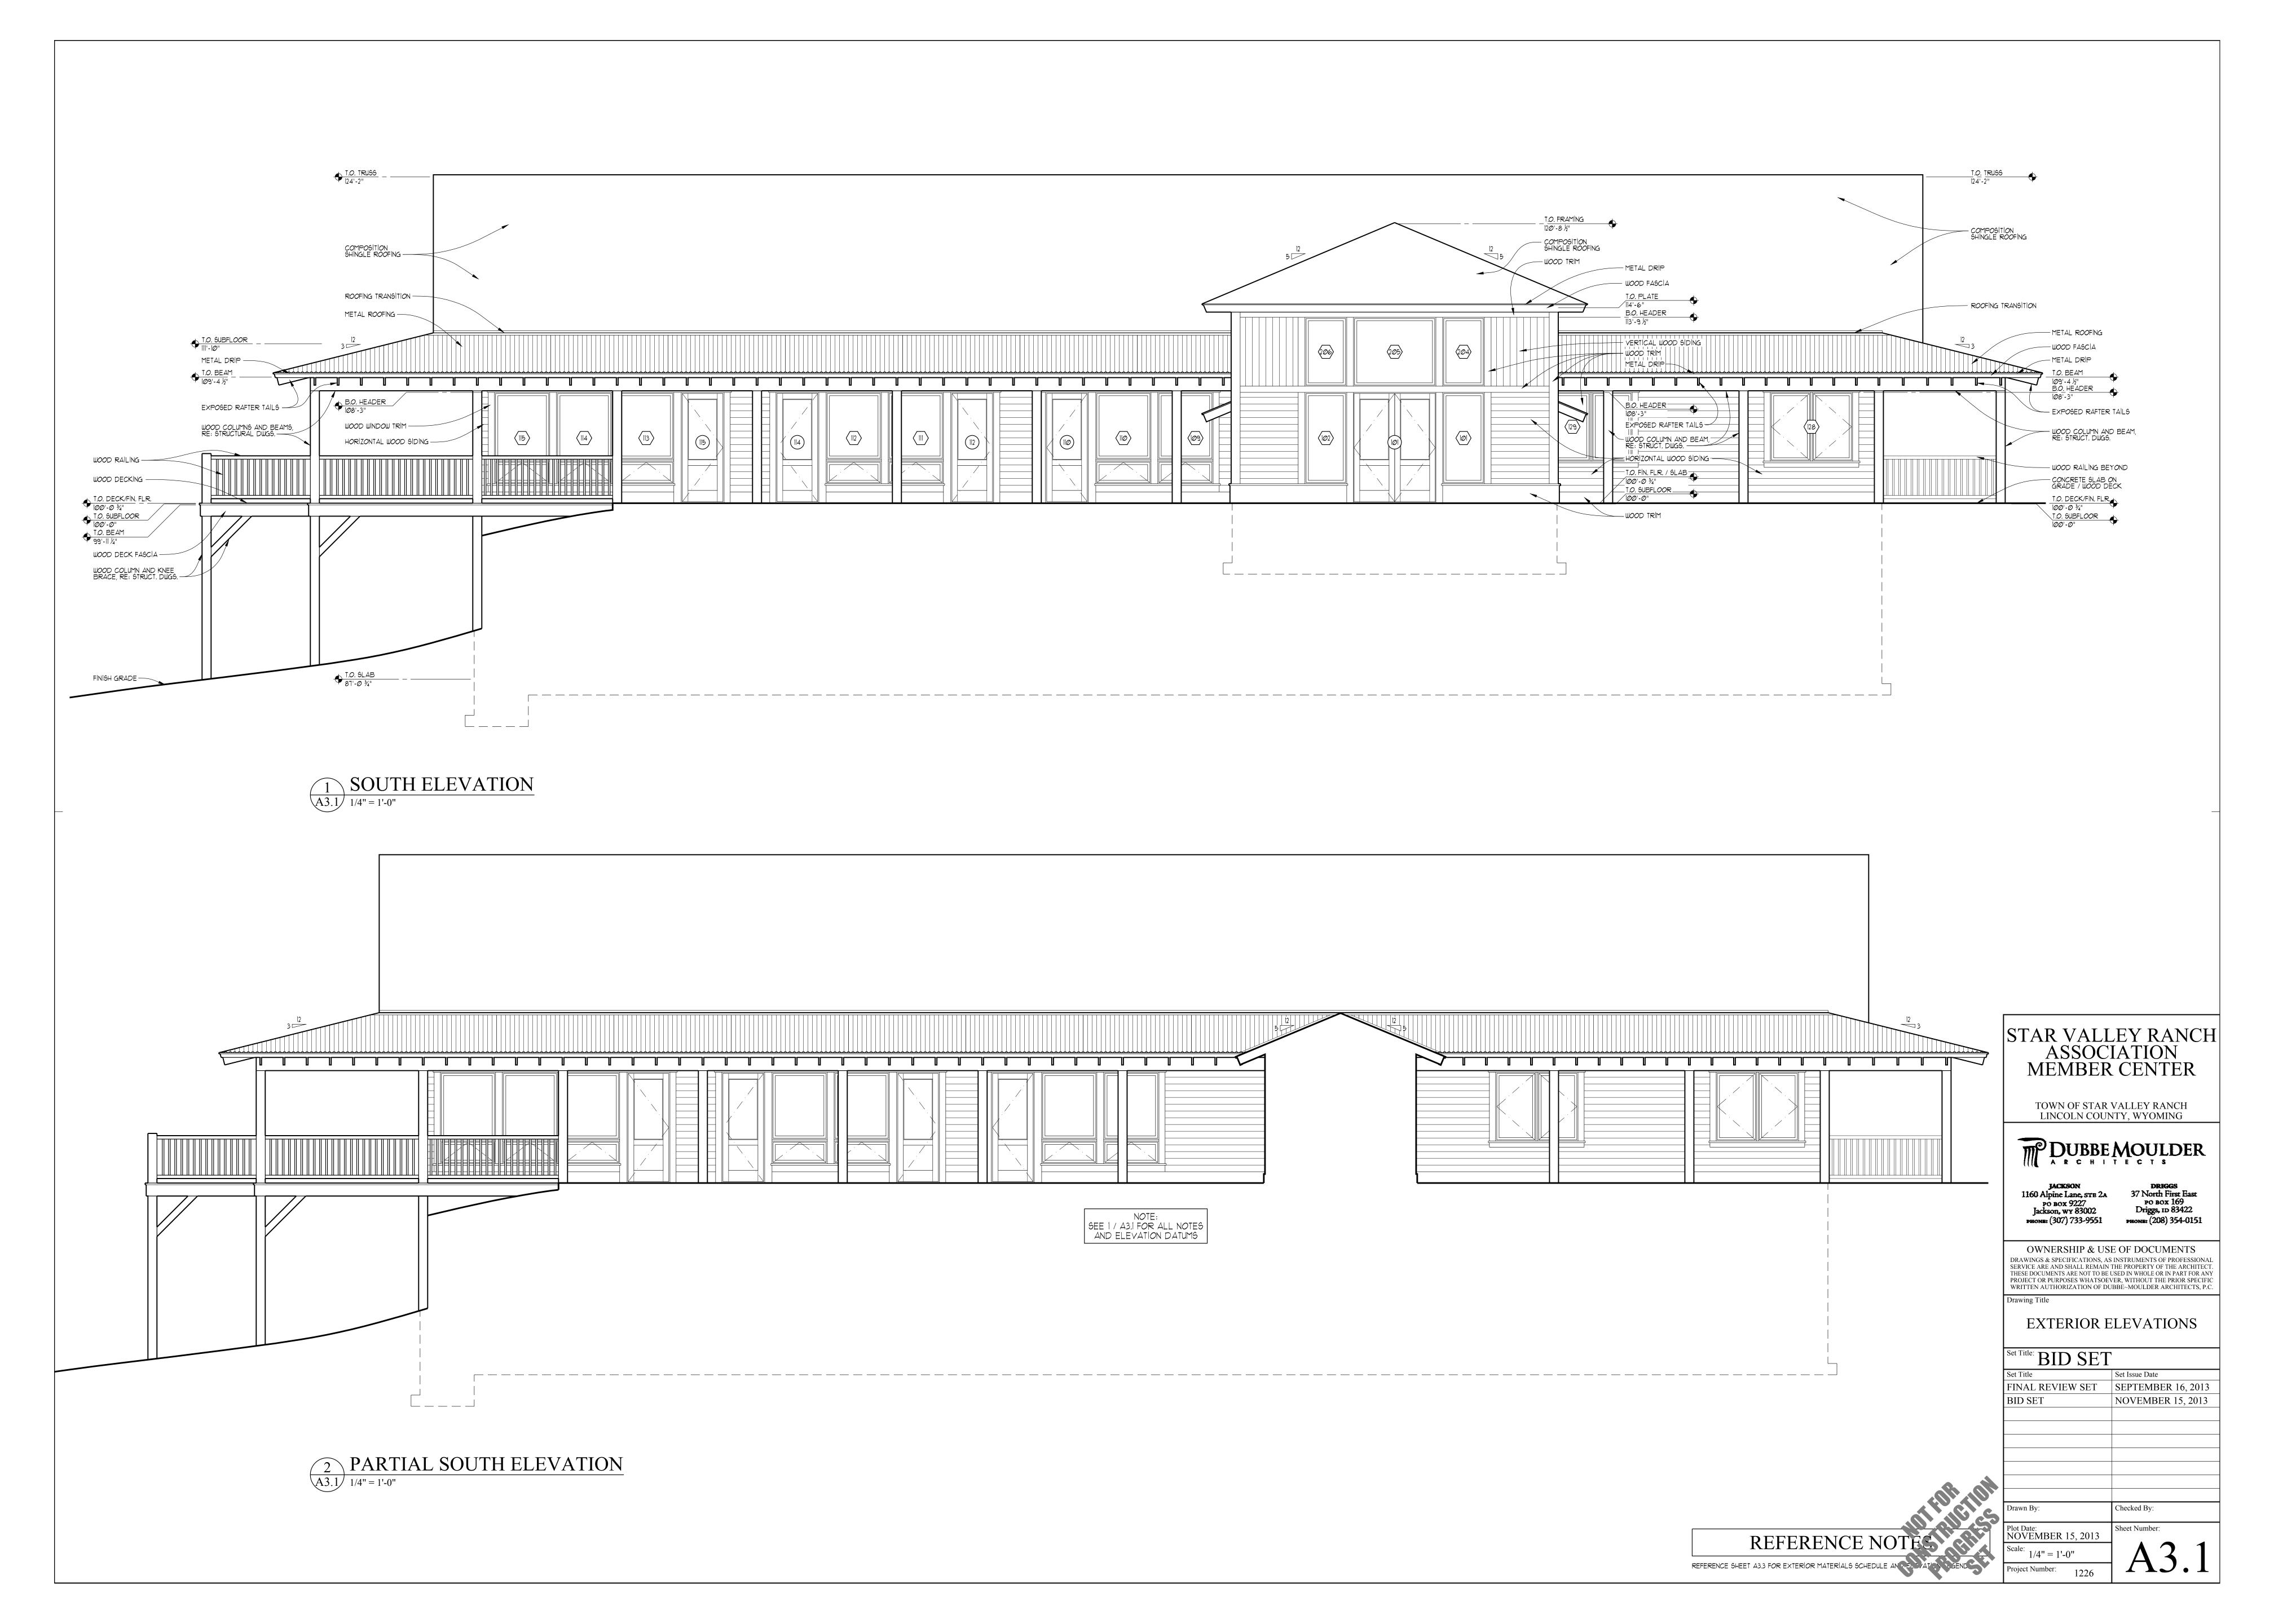STAR VALLEY RANCH ASSOCIATION MEMBER CENTER

TOWN OF STAR VALLEY RANCH LINCOLN COUNTY, WYOMING

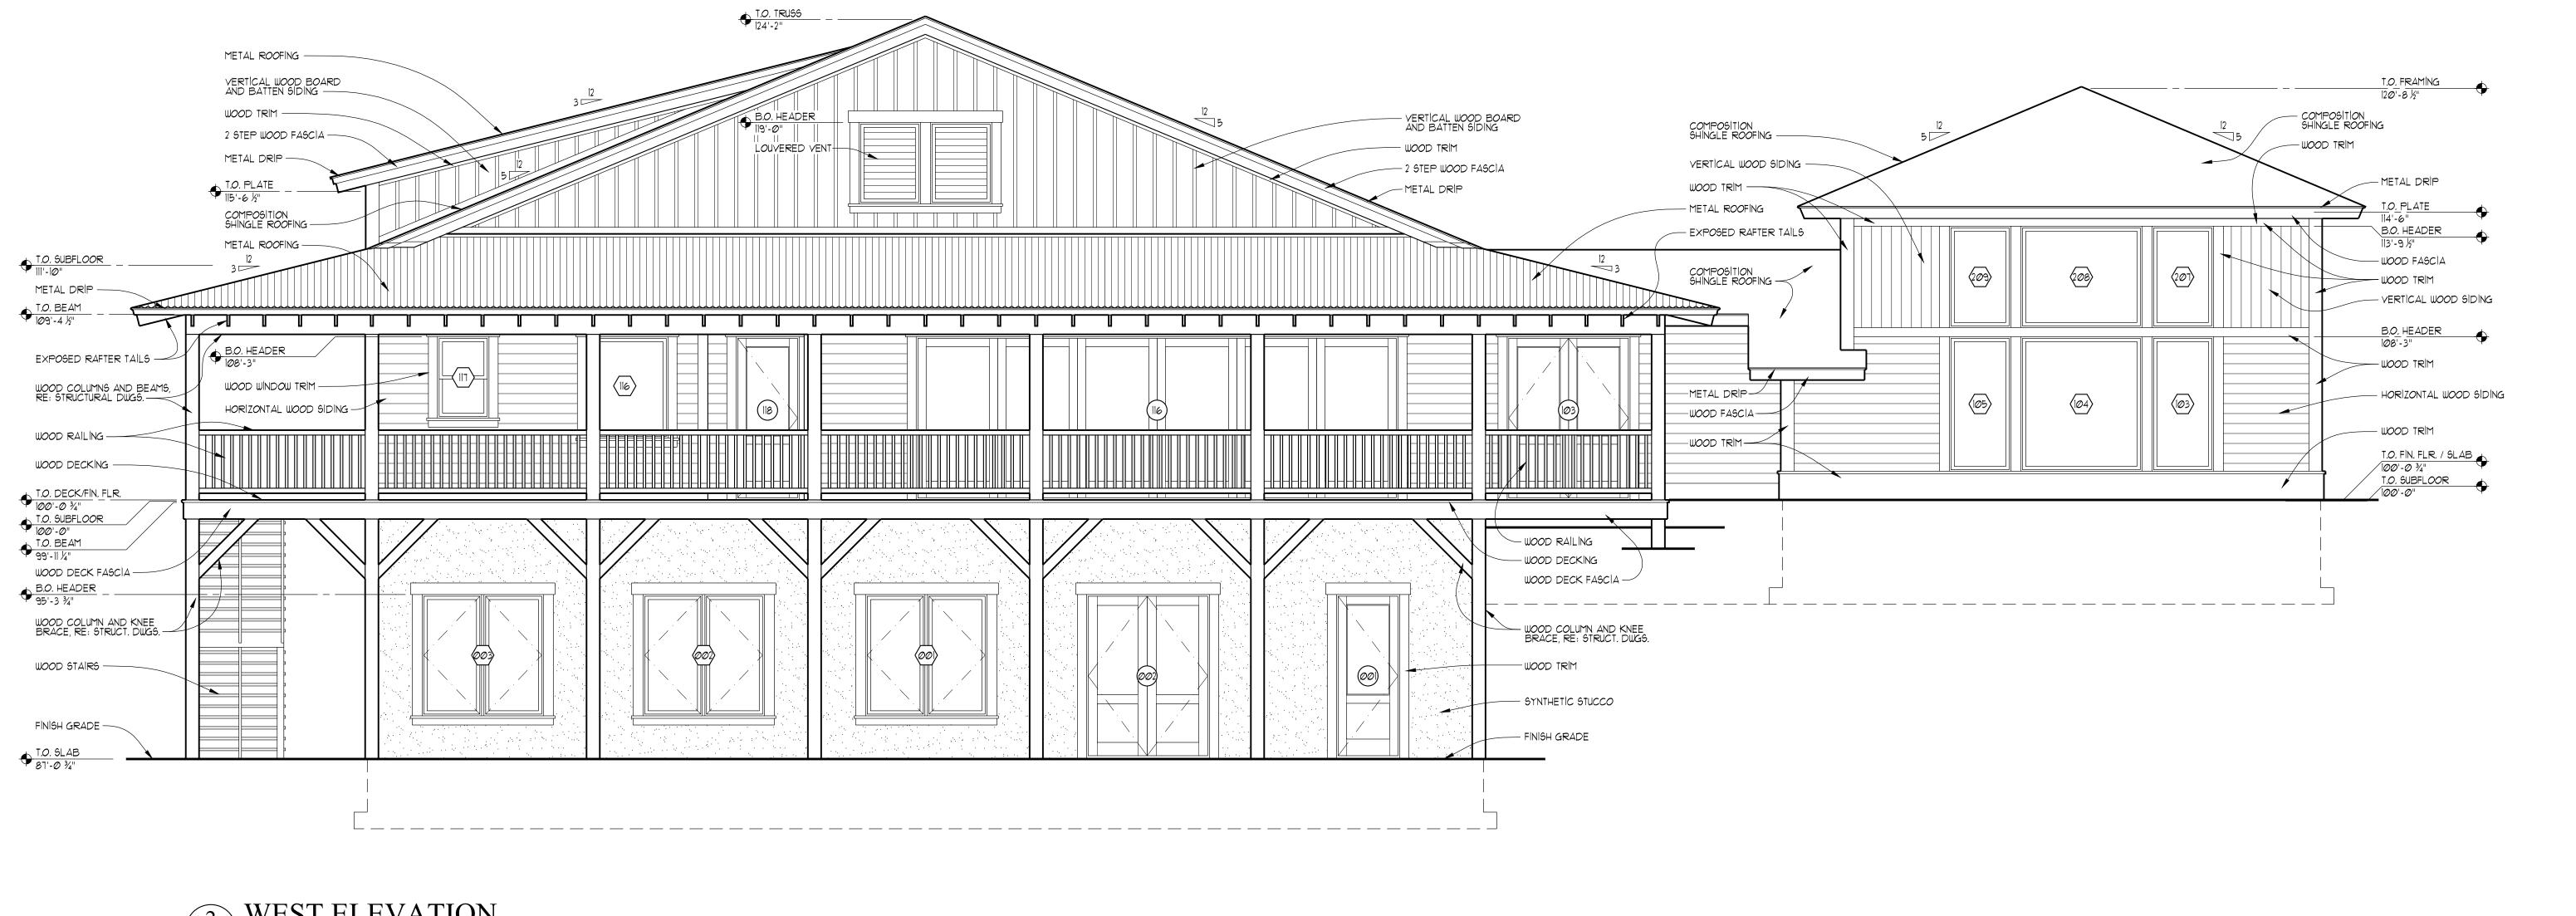

JACKSON DRIGGS

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Drawing Title

EXTERIOR ELEVATIONS

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Set Title	Set Issue Date		
FINAL REVIEW SET	SEPTEMBER 16, 2013		
BID SET	NOVEMBER 15, 2013		
Drawn By:	Checked By:		

Plot Date:
NOVEMBER 15, 2013
Scale:
1/4" = 1'-0"
Project Number:
1226

